Barnali Banerjee and Subhro Guhathakurta 351 SINCLAIR AVE NE ATLANTA GA 30307 770—243—3942 (Barnali) 480—463—4262 (Subhro) ADAM STILLMAN 350 SINCLAIR AVE NE ATLANTA, GA 30307 770-330-3389

STANDARD CONSTRUCTION CODES:

International Building Code, 2018 Edition, with Georgia Amendments (2020) International Residential Code, 2018 Edition, with Georgia Amendments (2020) International Fire Code, 2018 Edition (no Georgia Amendments) International Plumbing Code, 2018 Edition, with Georgia Amendments (2020) International Mechanical Code, 2018 Edition, with Georgia Amendment (2020) International Fuel Gas Code, 2018 Edition, with Georgia Amendment (2020) National Electrical Code, 2017 Edition (no Georgia Amendments)

International Energy Conservation Code, 2015 Edition, with Georgia Supplements and Amendments (2020) International Swimming Pool and Spa Code, 2018 Edition, with GA Amendments (2020) 2018 NFPA 101 - Life Safety Code 2018 Edition with State Amendments (2020)

PROJECT NAME: Banerjee/Guhathakurta Residence SCOPE OF WORK: Interior renovations to existing house; construct two-story rear addition with bedrooms, closets, bath, and exterior wood stairs; demo portion of existing timber retaining walls; replace rear kitchen windows. TYPE OF CONSTRUCTION: V-B NUMBER OF STORIES: 2

FLOOR AREAS:

MAIN (EXISTING): 1330 sf MAIN (ADDITION): 171 sf UPPER (ADDITION): 344 sf TOTAL: 1845 sf

BUILDING HEIGHT: 24'-1"

NOTE: NO ATTIC SPACE EXCEEDS 7' HEADROOM

UNHEATED FLOOR AREAS:

PORCH (EXISTING): 190 sf PATIO (EXISTING): 146 sf

FLOOD HAZARD: NO TYP. DEAD LOADS: 10 psf TYP. LIVE LOADS: 40 psf TYP. ROOF LOADS: 20 psf LIVE/15 psf DEAD WIND SPEED/CATEGORY: 115 mph/B TERMITE: SEVERE WEATHER: MODERATE FROST LINE DEPTH: 12" MEAN ANNUAL TEMP: 66.2° WINTER DESIGN TEMP: 22° GROUND SNOW LOAD: 5 psf SEISMIC DESIGN CATEGORY: B

DRAWING INDEX:

COVER SHEET SITE PLAN FLOOR PLANS FRONT & REAR ELEVATIONS LEFT & RIGHT ELEVATIONS

LINE OF SIGHT DIAGRAM

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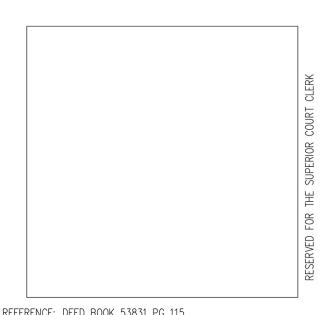
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ISSUED FOR CONSTRUCTION

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provisions listed herein. title COVER SHEET **scale** 3/16" = 1'-0" checked APS sheet no. 10-11-2021 project no.

351Sinclair



REFERENCE: DEED BOOK 53831 PG 115 PLAT BOOK 4 PG 56

FLOOD HAZARD NOTE: THIS PROPERTY IS NOT LOCATED IN A FLOOD HAZARD AREA AS DEFINED BY FIRM MAP OF FULTON COUNTY, GEORGIA 13121C0263G EFFECTIVE DATE SEPTEMBER 18, 2013 SURVEY DATA:

TYPE OF SURVEY: RETRACEMENT
SOURCE OF TITLE DESCRIPTION FOR SUBJECT
PROPERTY: DB 53831 PG 115
PROPERTY OWNER AT TIME OF SURVEY:
SUBHRAJIT GUHATHAKURTA & BARNALI BANERJEE
PARCEL NUMBER:14 001500120562

BASIS OF BEARINGS IS A SINGLE COMPASS READING & ANGLES TURNED; ELEVATION DATUM ASSUMED FROM FULTON COUNTY GIS

TOTAL AREA: 5,352 SQ FT, 0.12 AC

CALCULATED PLAT CLOSURE: 41,520

FIELD DATA:


DATE OF FIELD SURVEY 8-23-2021

THE CALCULATED POSITIONAL TOLERANCE BASED ON REDUNDANT LINEAR MEASUREMENTS OF OBSERVED POSITIONS WAS FOUND TO BE 0.015 FEET.

ZONING: R-5 HOUSE = 1,330 S.F. CONCRETE DRIVE = 339 S.F. FRONT WALK / STEPS = 253 S.F. FRONT PORCH / STEPS = 190 S.F. CRAWLSPACE STEPS / PAD = 58 S.F. REAR CONCRETE PAVER PATIO = 246 S.F. WALL(S) = 176 S.F. IMPERVIOUS TOTAL = 2,592 S.F. LOT AREA = 5,352 S.F.

This plat is a retracement of an existing parcel or parcels of land and does not subdivide or create a new parcel or make any changes to any real property boundaries. The recording information of the documents, maps, plats, or other instruments which created the parcel or parcels are stated becomes

RECORDATION OF THIS PLAT DOES NOT IMPLY APPROVAL OF ANY LOCAL JURISDICTION, AVAILABILITY OF PERMITS, COMPLIANCE WITH LOCAL REGULATIONS OR REQUIREMENTS, OR SUITABILITY FOR ANY USE OR PURPOSE OF THE LAND. Furthermore, the undersigned land surveyor certifies that this plat complies with the minimum technical standards for property surveys in Georgia as set forth in the rules and regulations of the Georgia Board of Registration for Professional Engineers and Land Surveyors and as set forth in 0.C.G.A. Section 15-6-67.

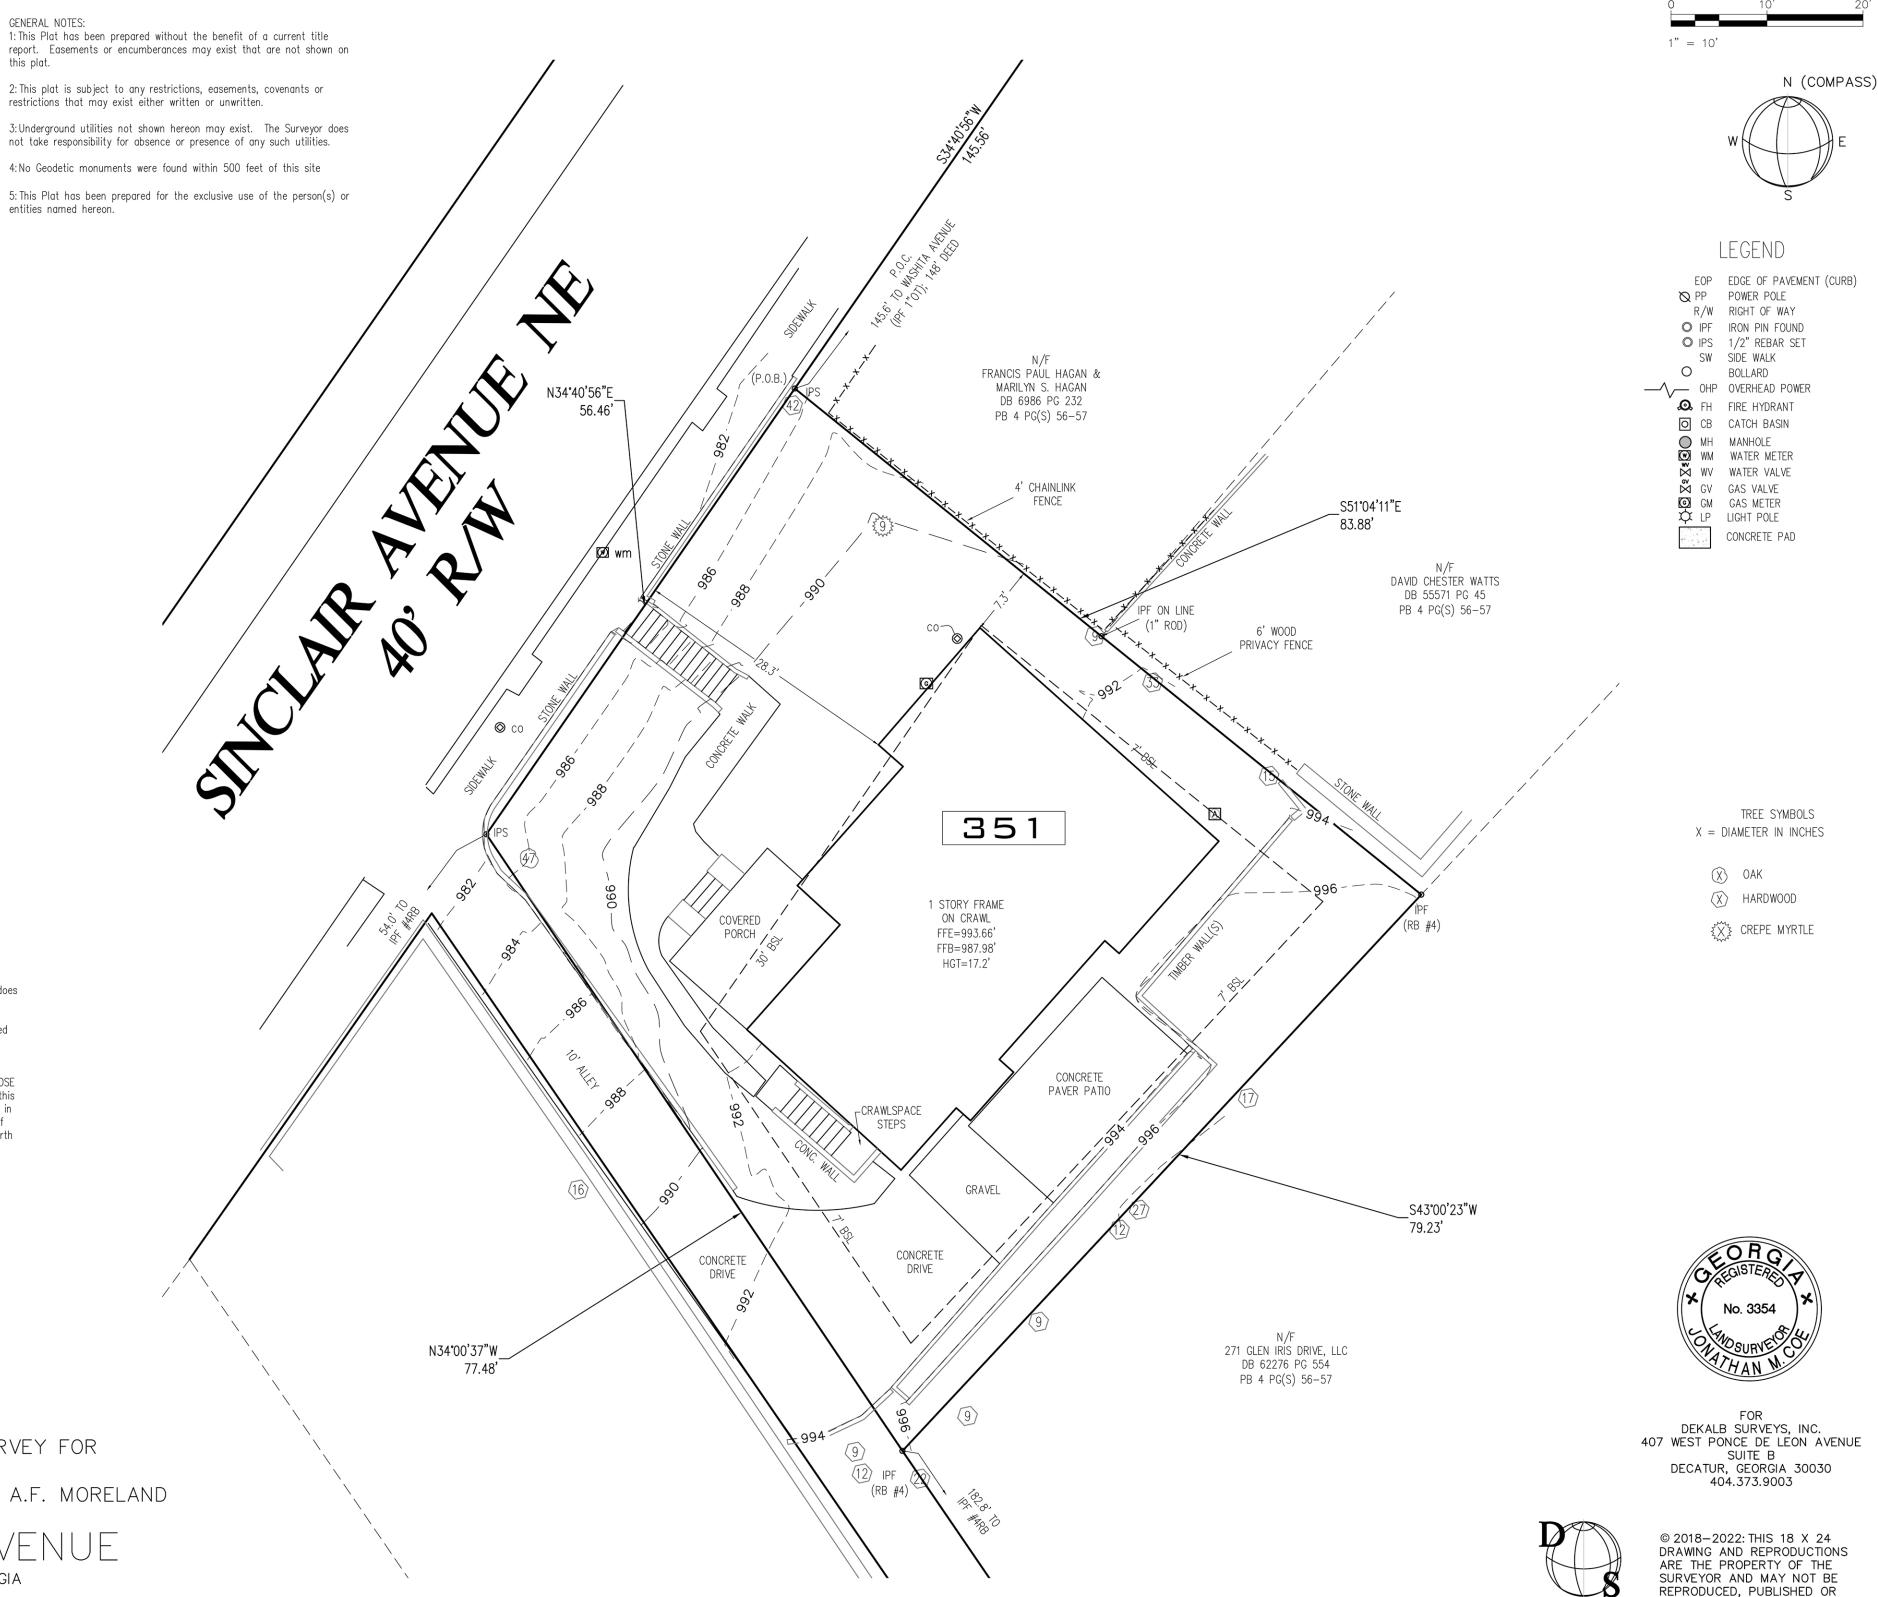

USED IN ANY WAY WITHOUT THE WRITTEN PERMISSION OF THIS

SURVEYOR

www.dekalbsurveys.com


BOUNDARY & TOPOGRAPHIC SURVEY FOR BARNALI BANERJEE

P/O LOT 1, PROPERTY OF MAJ. A.F. MORELAND

351 SINCLAIR AVENUE

CITY OF ATLANTA, FULTON COUNTY, GEORGIA

LAND LOT 15, DIST 14 DATE: AUGUST 24, 2021

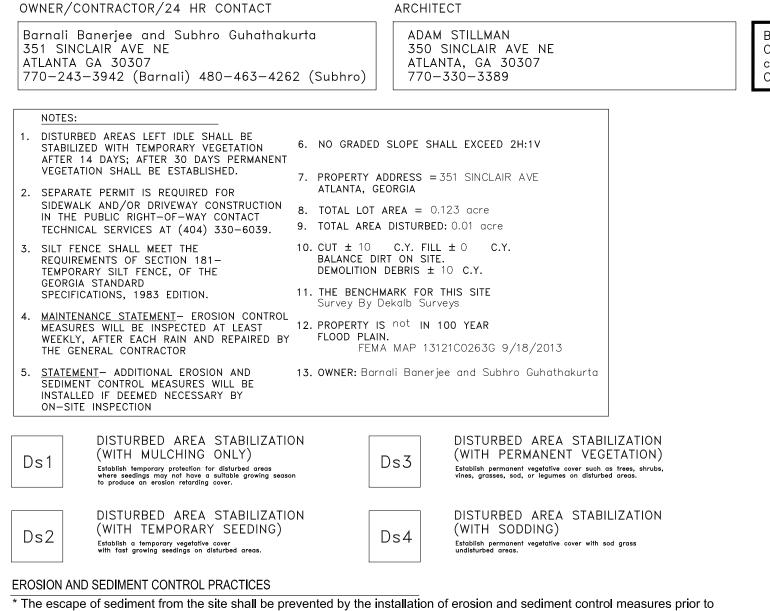


* Erosion and sediment control measures shall be maintained at all times. Additional measures beyond the approved plan shall be implemented as necessary. * Disturbed areas idle 14 days shall be stabilized with temporary vegetation; disturbed areas idle 30 days shall be stabilized with permanent vegetation. * Erosion and sediment control measures shall be inspected at least twice weekly, after each rain, and repaired as necessary. * Additional erosion and sediment control measures shall be installed if determined necessary by on-site inspection. * Silt fence shall meet the requirements of Section 171 - Type C temporary silt fence, of the Georgia Department of Transportation Standard Specifications, 1993 Edition.


VEGETATIVE PLAN FALL SEEDING


or concurrent with land-disturbance activities.

* Treat soil with 40lbs/1000sf lime, till soil, and water thoroughly. Seed with 6-8lbs./1000sf Bermuda (Cynodon dactylon) and Centipede (Eremochloa ophiuroides) with 4lbs/1000sf starter fertilizer (20-27-5) and mulch with straw at a rate of 1 bale/800sf. Fertilize with 24-6-12 at 60 and 150 days after seeding. Skip 150 day fertilizing if WITHIN 30 days of Spring Seeding. SPRING SEEDING

* Treat soil with 40lbs/1000sf lime, till soil, and water thoroughly. Seed with 6-8lbs./1000sf Ryegrass (Lolium multiflorum) and Red Fescue (Festuca rubra) with 4lbs/1000sf starter fertilizer (20-27-5) and mulch with straw at a rate of 1 bale/800sf. Fertilize with 24-6-12 at 60 and 150 days after seeding. Skip 150 day fertilizing if WITHIN 30 days of Fall Seeding. * Test soil and reapply 40lbs/1000sf lime as needed on an annual basis

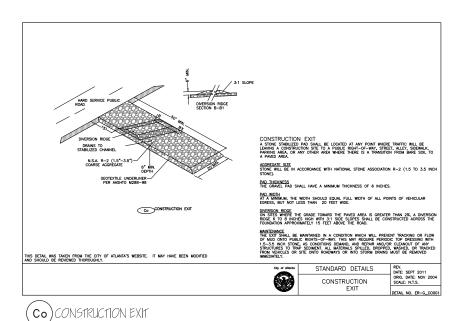

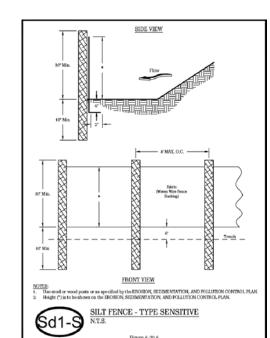

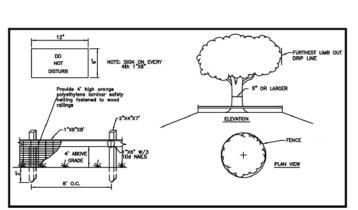

NOTES:

1. ALL TREE PROTECTION AREAS TO BE PROTECTED FROM SEDIMENTATION.

2. ALL TREE PROTECTION DEVICES TO BE INSTALLED PRIOR TO THE START OF THE LAND DISTURBANCE, AND MAINTAINED UNTIL FINAL LANDSCAPING


3. ALL TREE PROTECTION FENCING TO BE INSPECTED DAILY, AND REPAIRED OR REPLACED AS NEEDED.


4. NO PARKING, STORAGE OR OTHER CONSTRUCTION ACTIVITIES ARE TO OCCUR WITHIN TREE PROTECTION AREA.

5. ALL REQUIRED VEGETATION MUST BE MAINTAINED FOR TWO GROWING SEASONS AFTER THE DATE OF FINAL INSPECTION. TREE PROTECTION FENCE

(Ts1) TREE PROTECTION FENCE



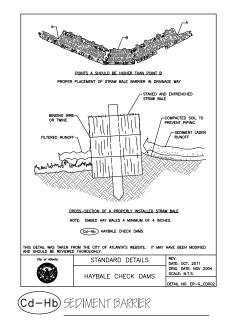

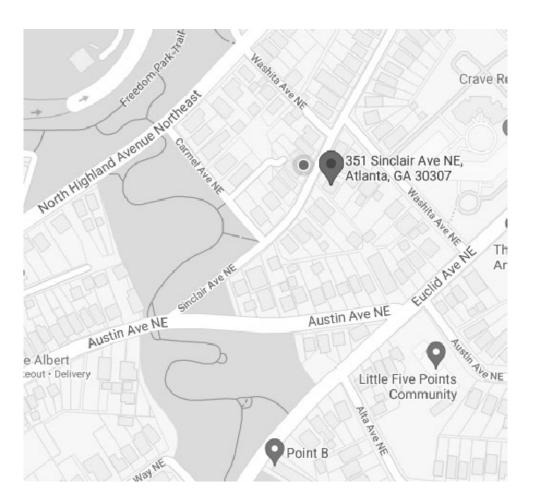

VICINITY MAP

NOT TO SCALE

Before starting land-disturbance activities, the Contractor is required to schedule a preconstruction meeting with Erosion & Sediment ontrol. Call (404) 546-1300

> \$AMOUNT = \$100.00[(# OF TREES DESTROYED + # OF TREES LOST)]- # OF TREES REPLACED] + \$30.00 [(# DBH INCHES DESTROYED + # DBH INCHES LOST) - # CALIPER INCHES REPLACED] + \$100.00 x # OF TREES DESTROYED + \$100.00 x 0 = +\$ 0.00 $+ $100.00 \times 0 = +$ 0.00$ + \$100.00 x # OF TREES LOST TREE SYMBOL LEGEND - \$100.00 x # OF TREES REPLACED - \$100.00 \times 0 = -\$ 0.00 SYMBOL: DESCRIPTION: $+ $30.00 \times 0 = +$ 0.00$ + \$30.00 # DBH INCHES DESTROYED NEW TREE + \$30.00 # DBH INCHES LOST $+ $30.00 \times 0 = +$ 0.00$ - \$30.00 # CALIPER INCHES REPLACED - \$30.00 x 0 = -\$ 0.00() EXISTING TREE TO REMAIN (X) existing tree to be removed \$ AMOUNT =

TREES RECOMPENSE:

TREE REPLACEMENT CALCULATION CHART

NO WATERS OF THE STATE EXIST WITHIN 200' OF THE PROJECT SITE


SITE PLAN (PROPOSED)

1" = 20'-0"

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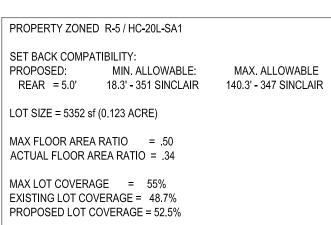
NOTE: LIMITS OF DISTURBANCE COINCIDE WITH SILT FENCE



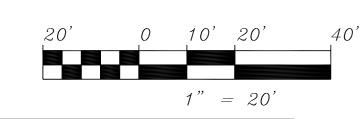

NO GRADED SLOPES SHALL EXCEED 2H:1V

--- EXISTING TO REMAIN --- EXISTING TO BE REMOVED --- NEW CONTOUR



EXISTING HVAC; NOT

EXISTING HOUSE OVER CRAWL/CELLAR

FFE = 993.66

VISIBLE FROM STREET

NEW CONCRETE LANDING

- NEW WOOD STEPS REMOVE PORTION OF

EXISTING TIMBER RETAINING

WALL AT ADDITION

FLOOR AREAS: LOT COVERAGE CALCULATIONS: MAIN (EXISTING): 1330 sf EXISTING: PROPOSED: UPPER (ADDITION): 344 sf 339 sf 339 sf CONCRETE DRIVE: FRONT WALK/STEPS: 253 sf 253 sf FRONT PORCH/STEPS: 190 sf 190 sf NOTE: NO ATTIC SPACE CRAWLSPACE STEPS/PAD: EXCEEDS 7' HEADROOM PAVER PATIO: 246 sf RETAINING WALLS: 176 sf 13 sf HVAC: PORCH (EXISTING): 190 sf NEW REAR STEPS/PAD: PATIO (EXISTING):

146 sf TOTAL:

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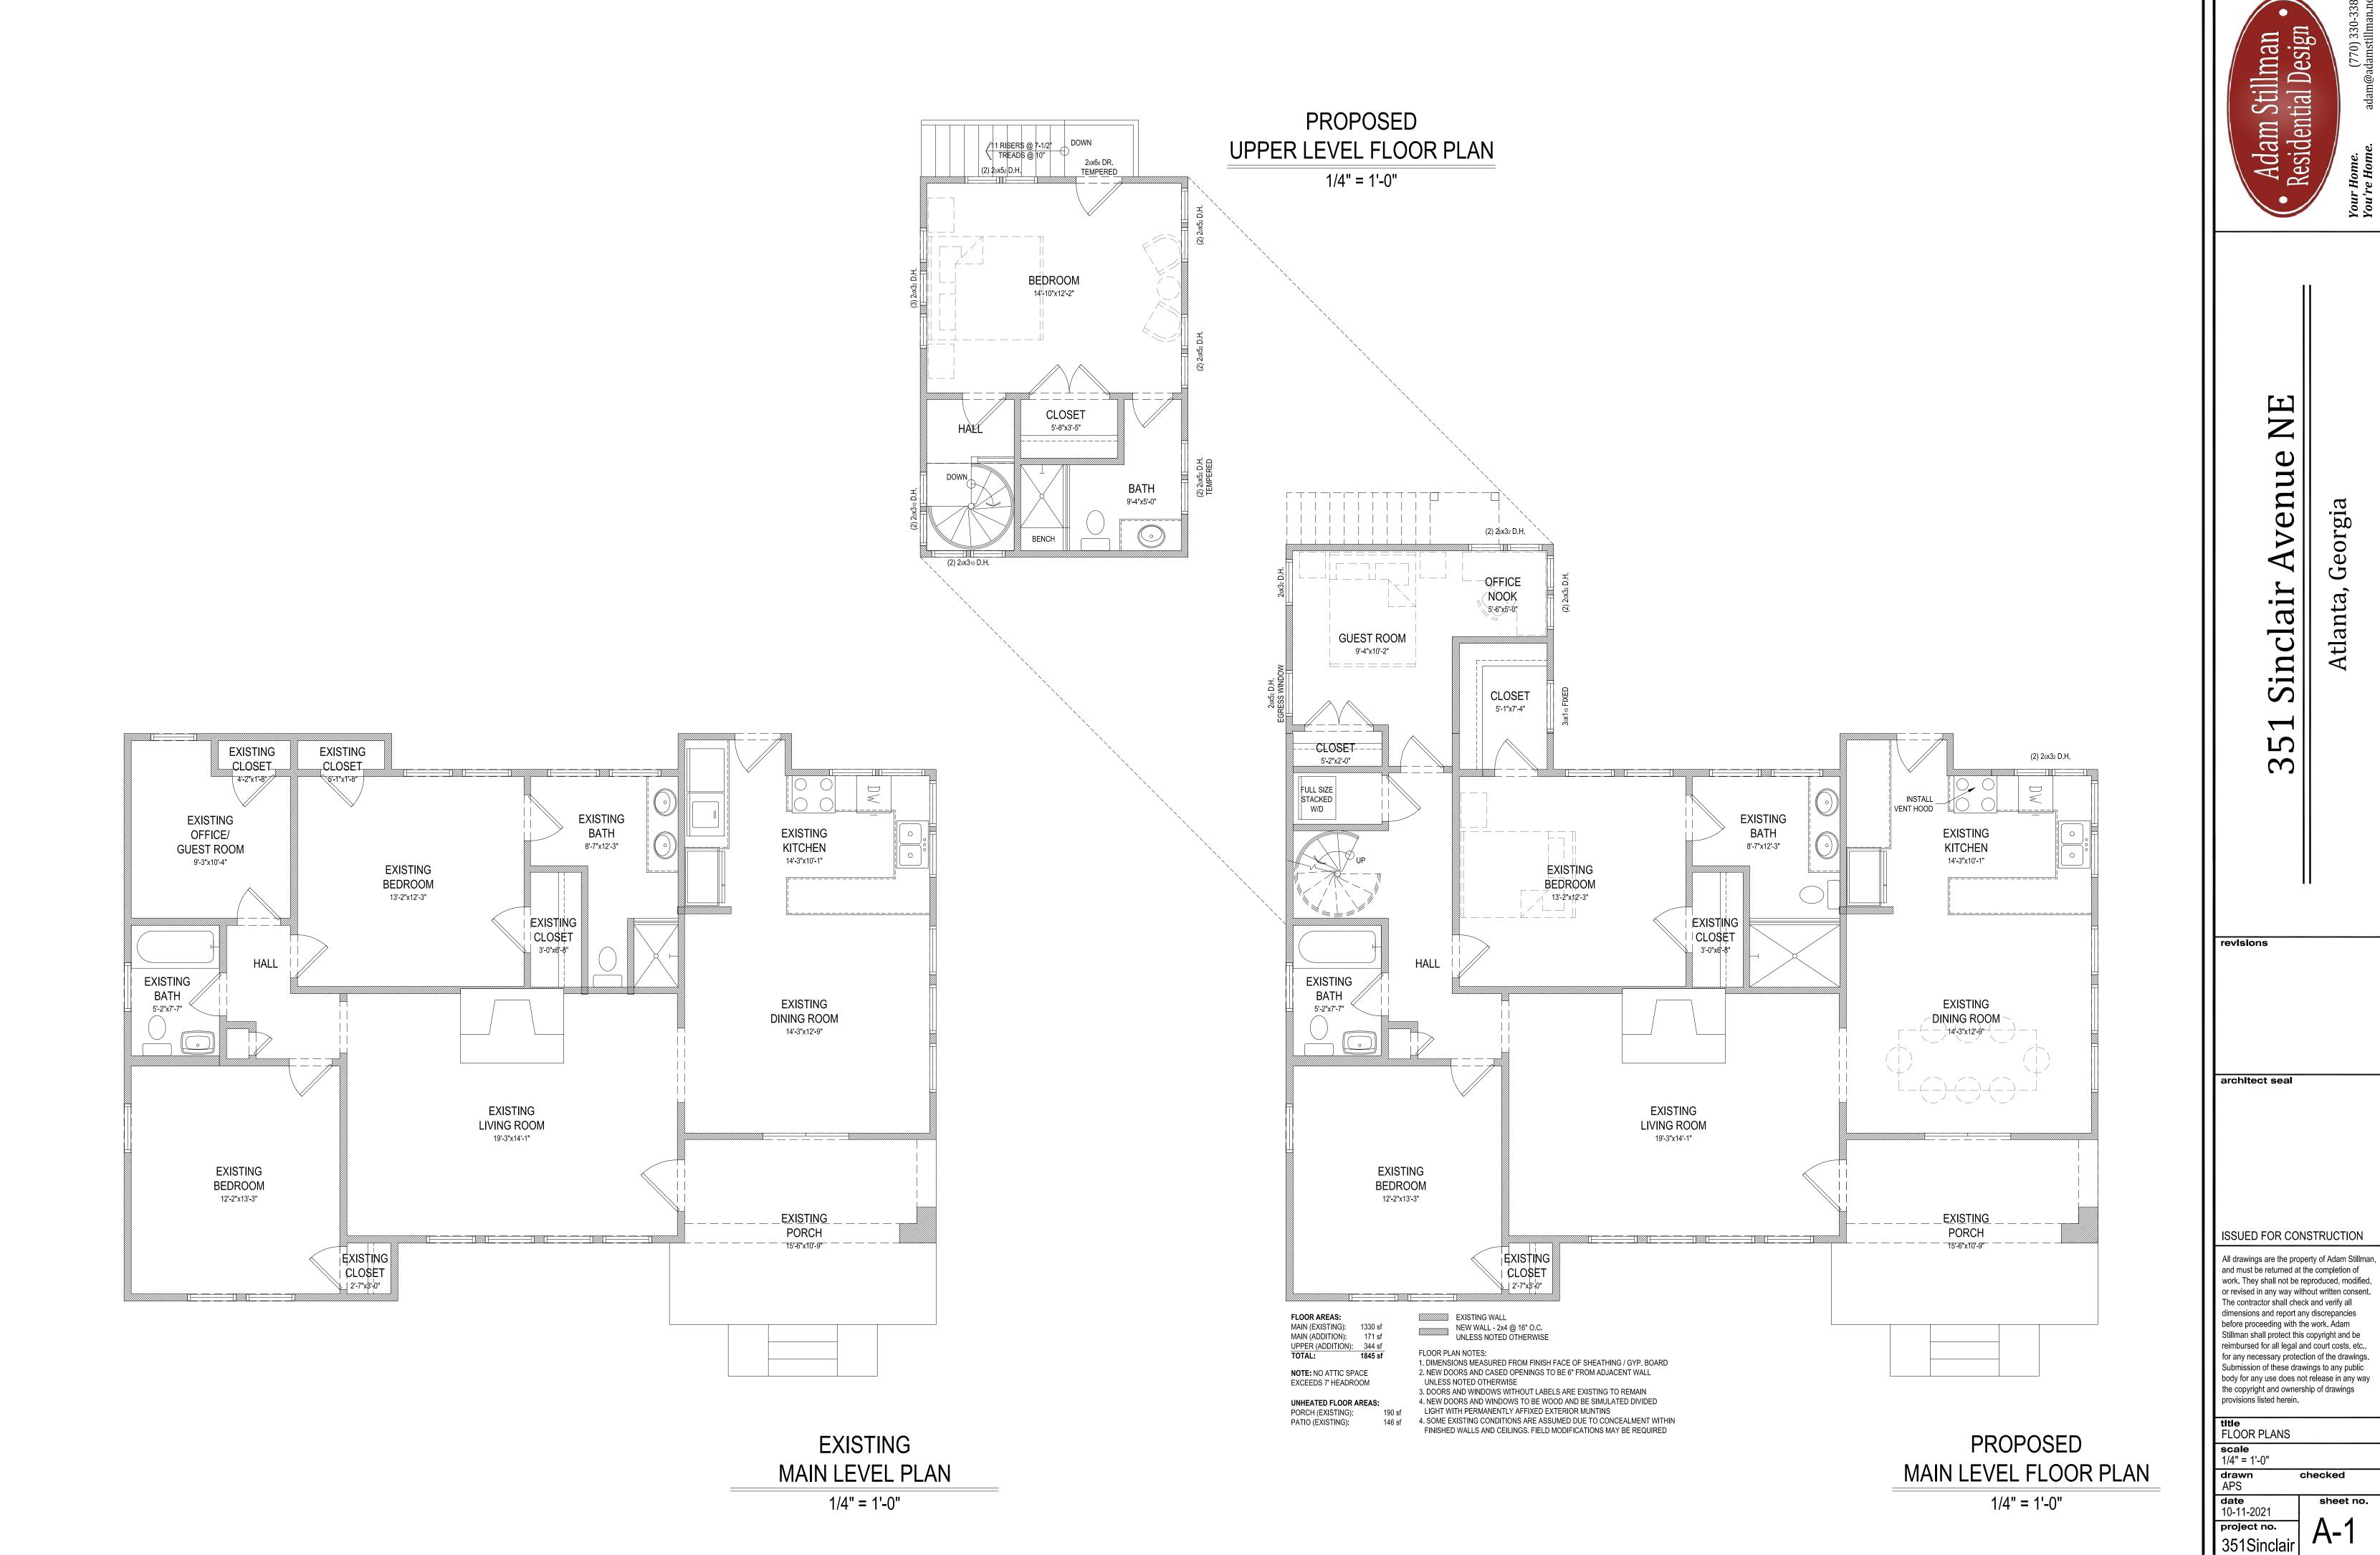
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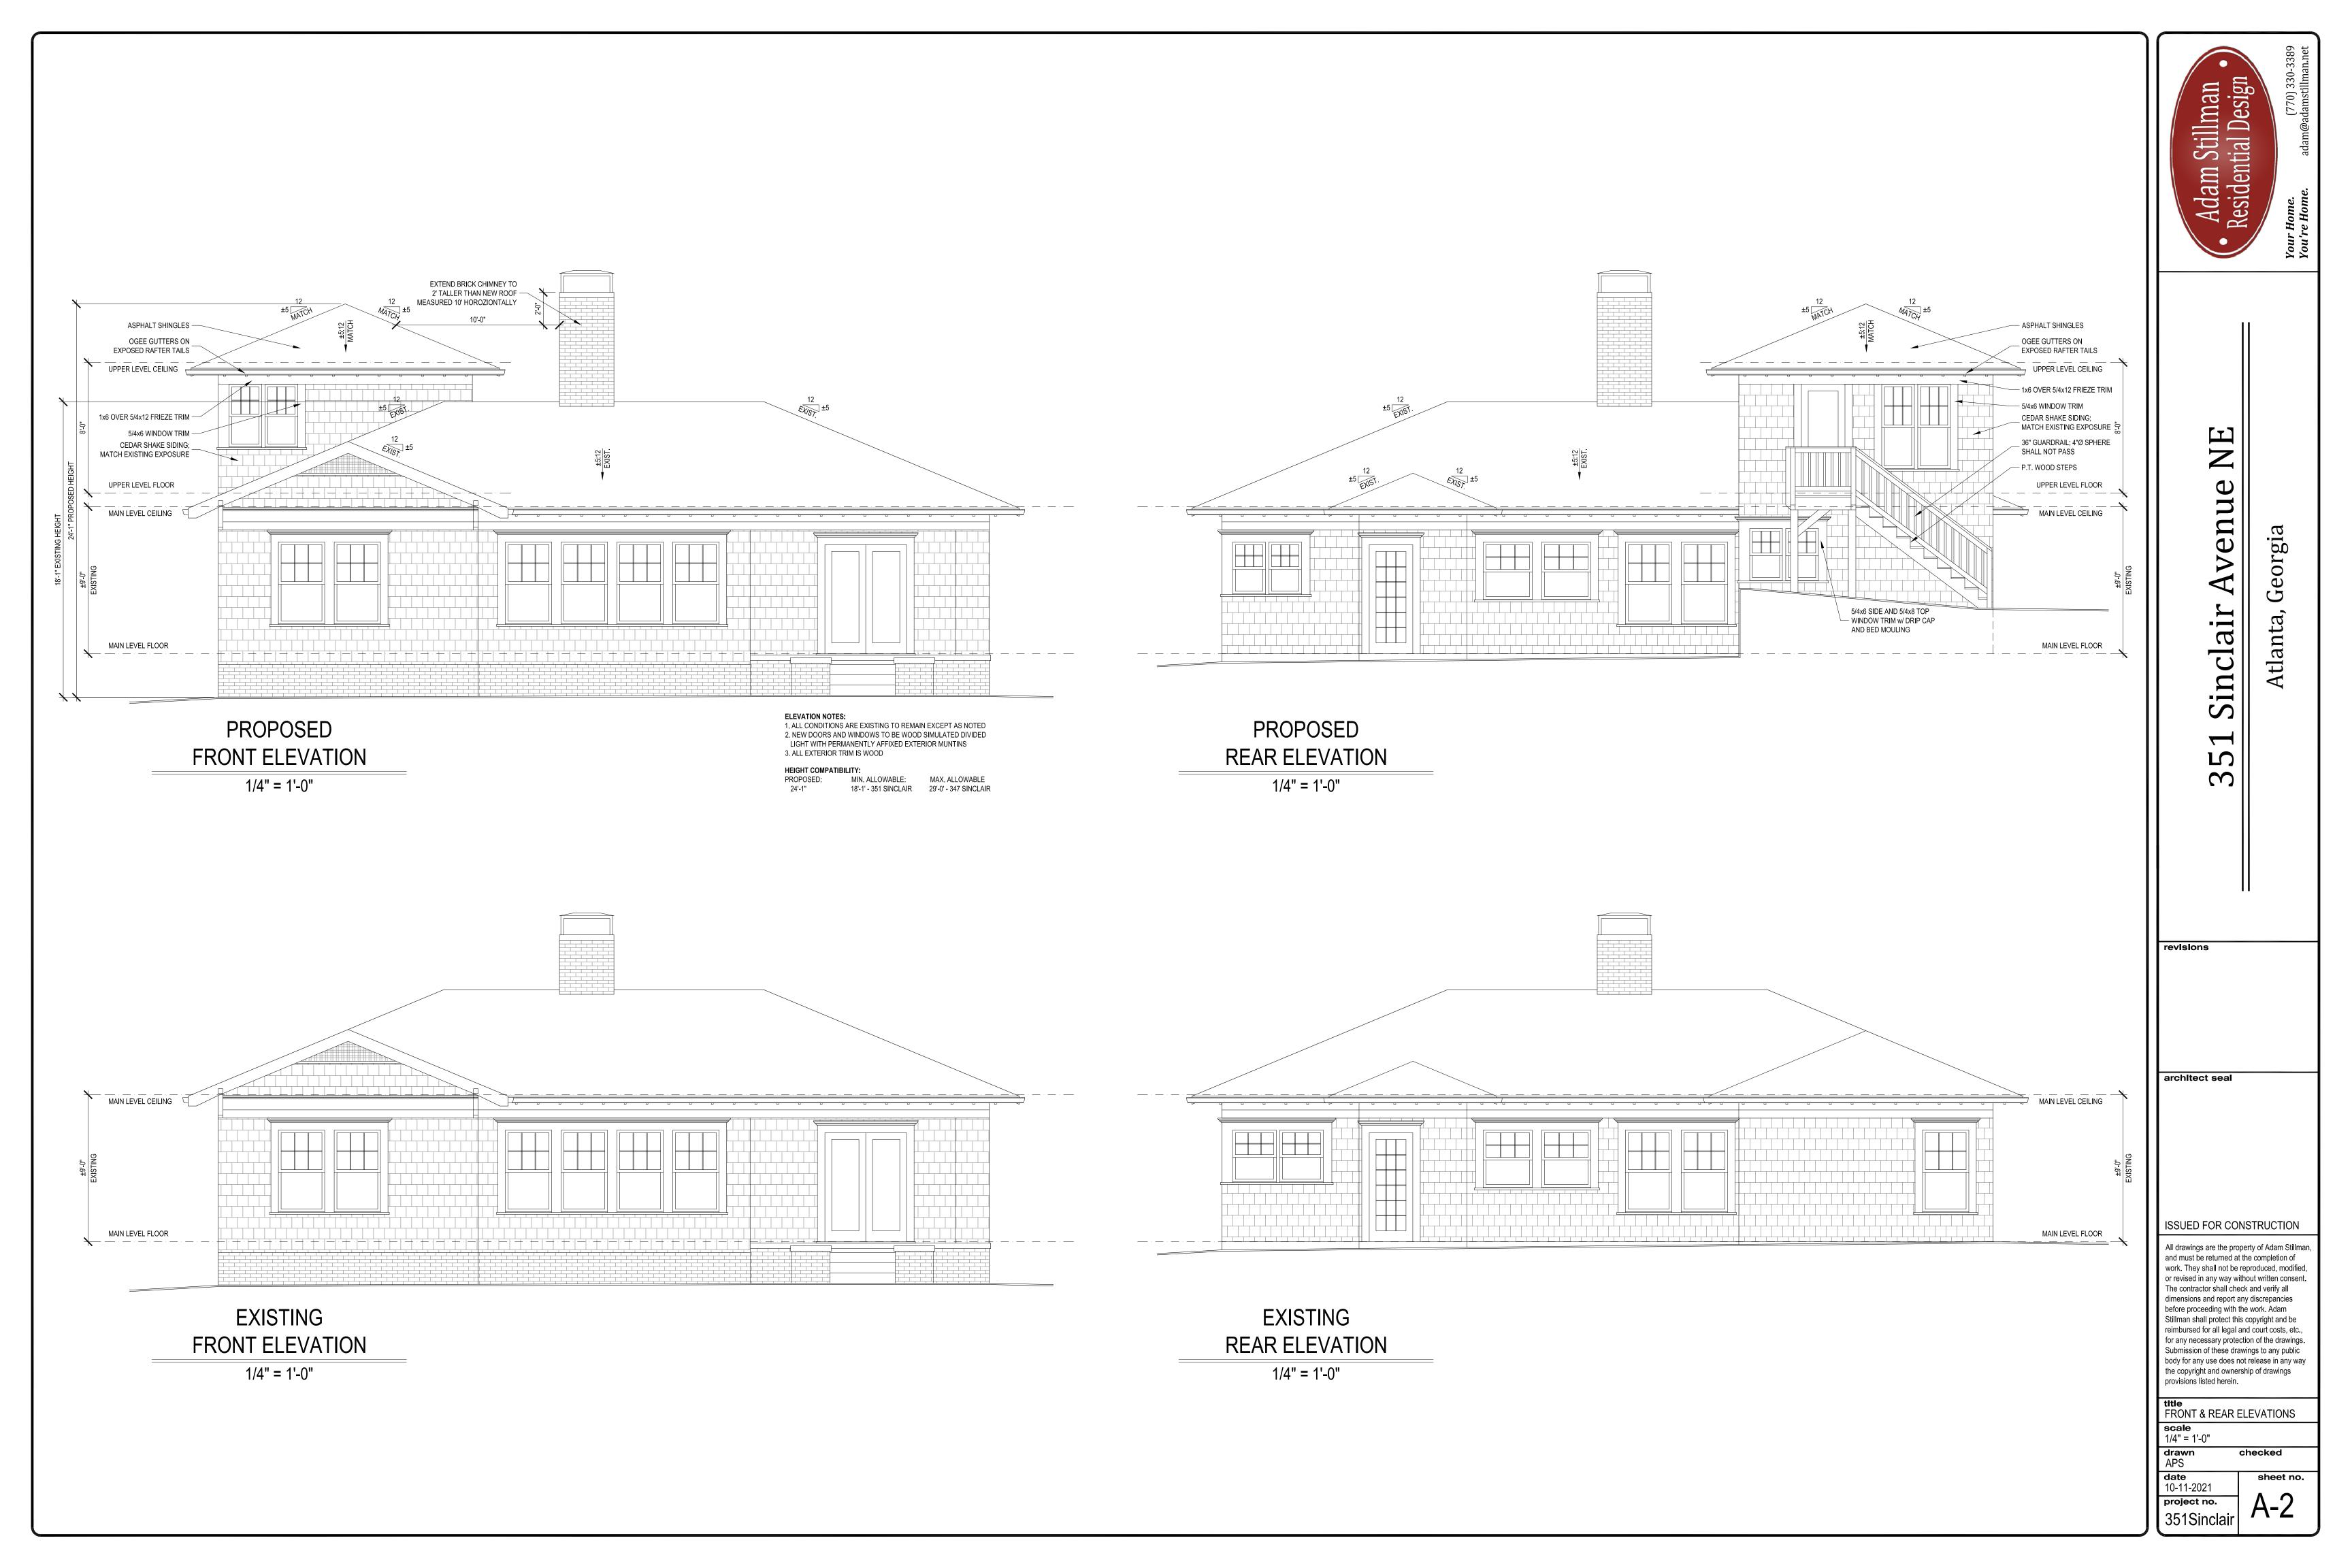
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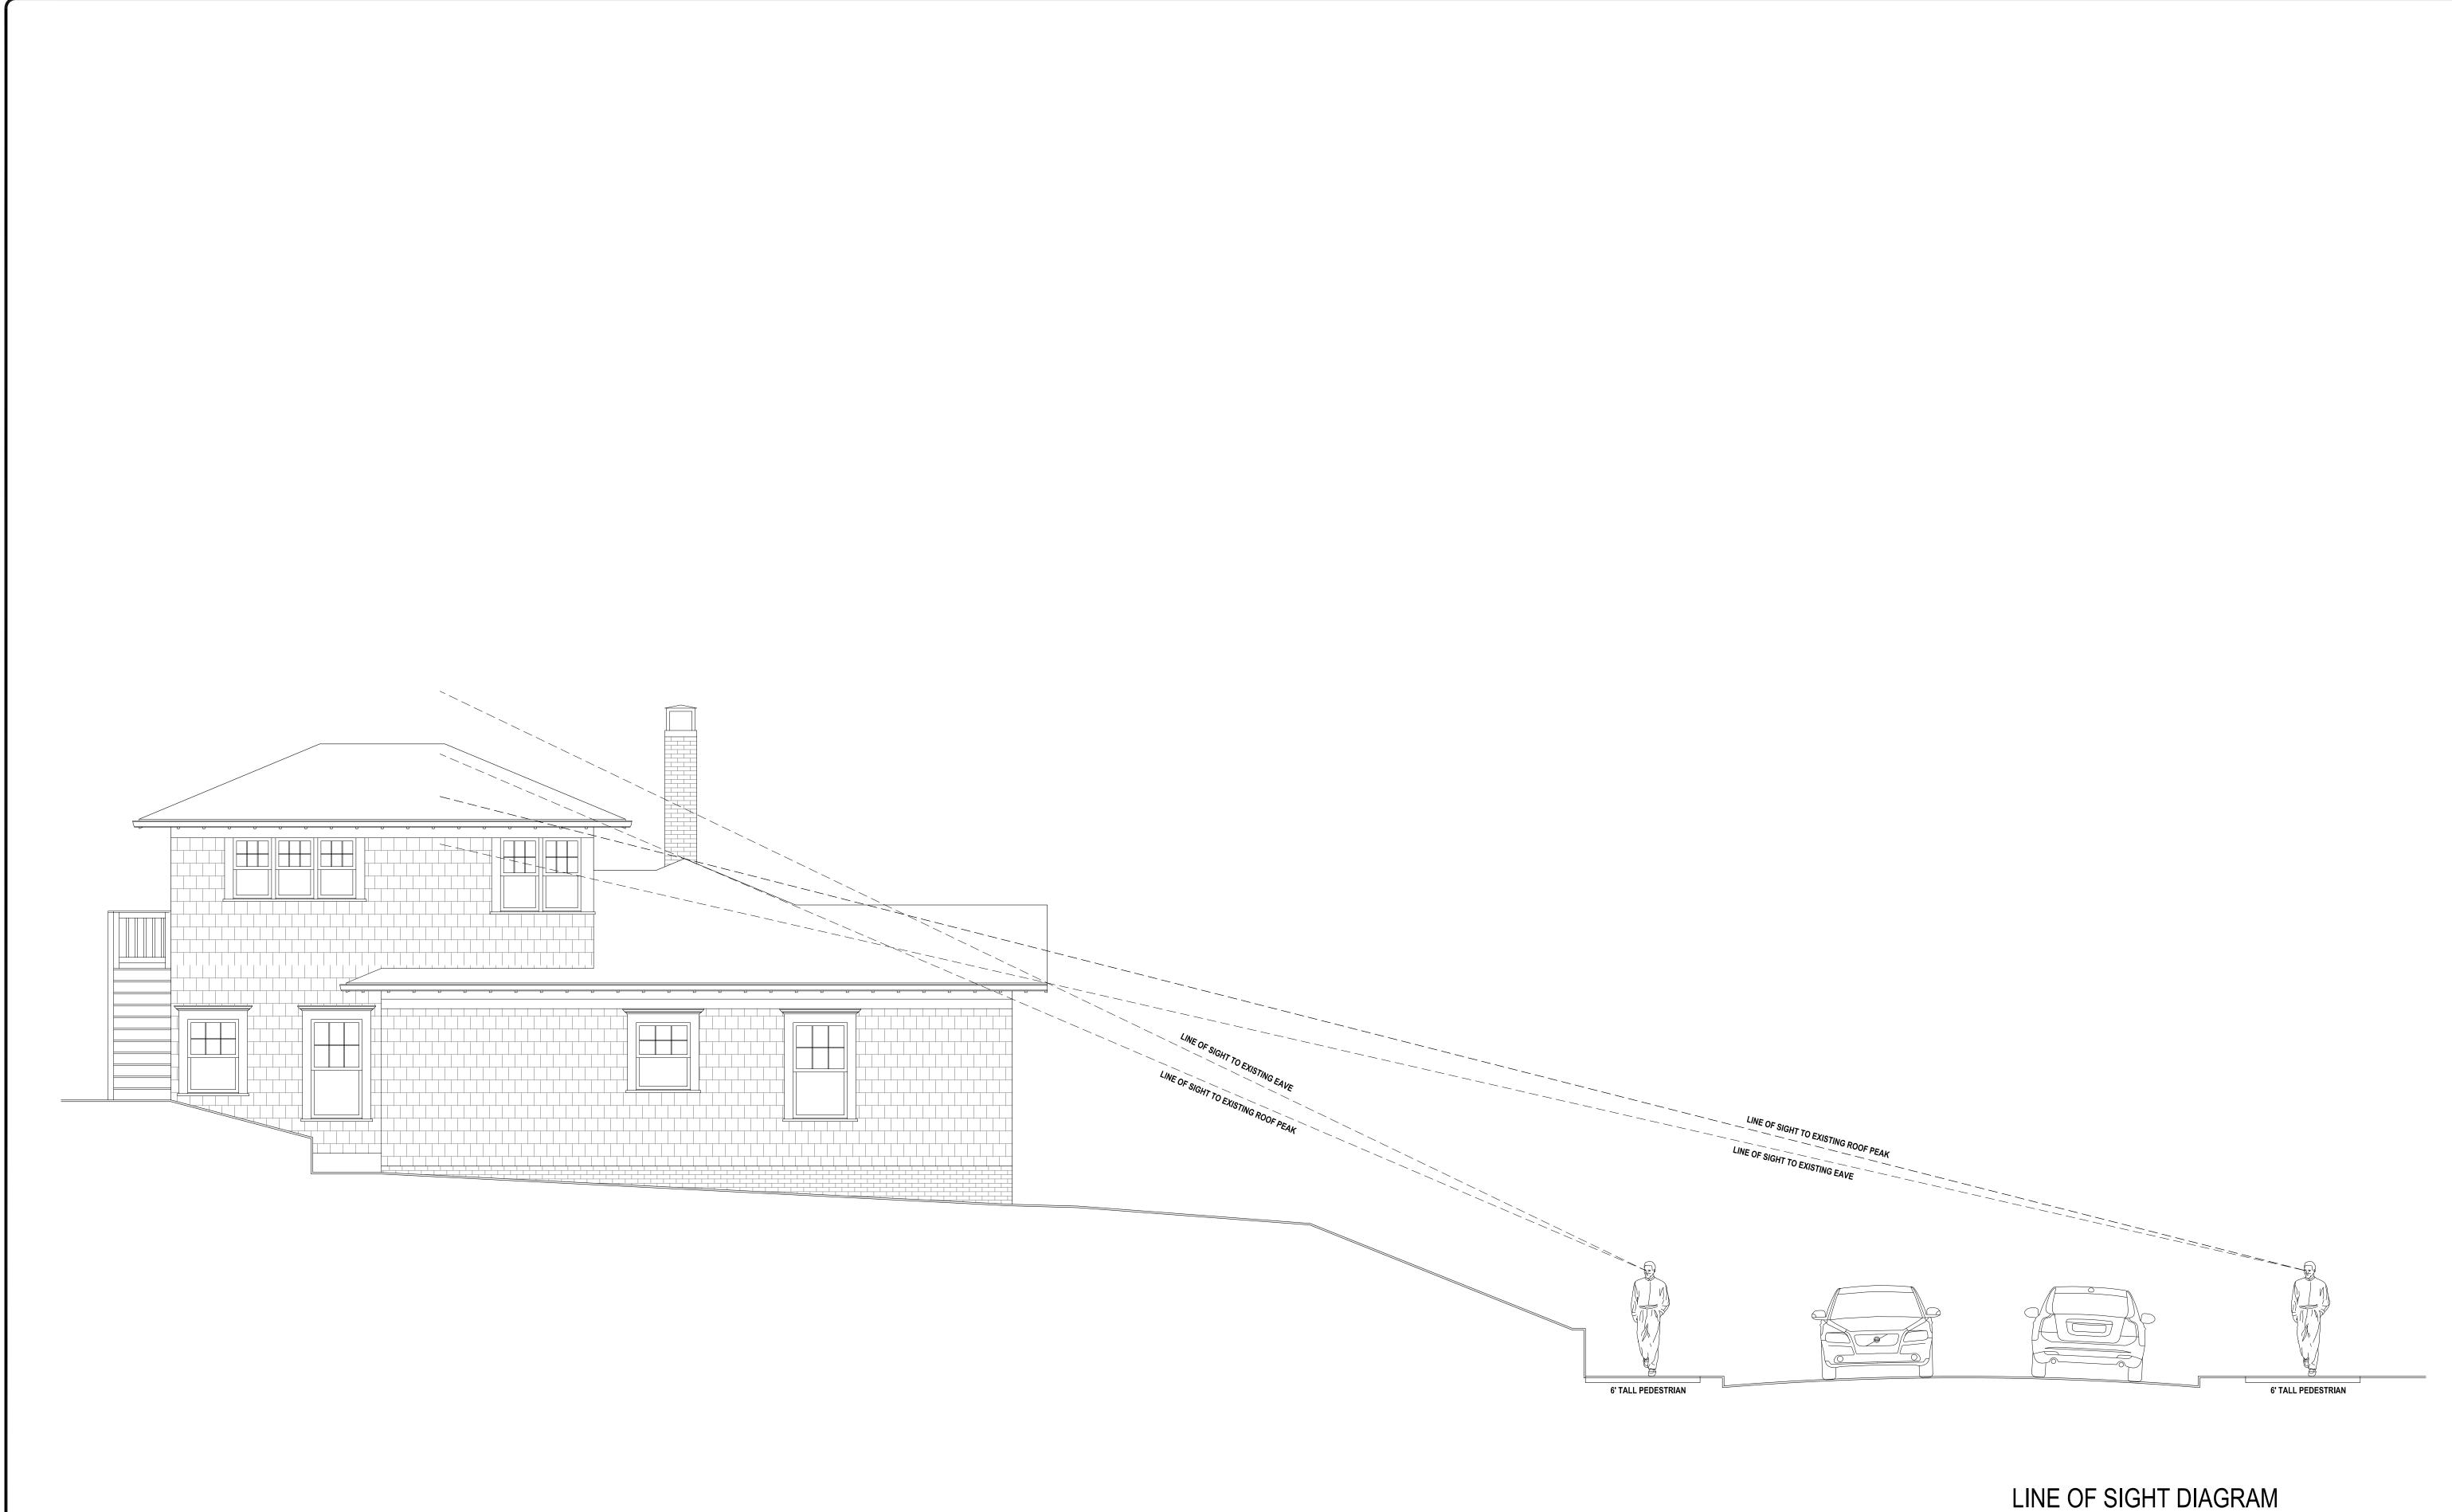
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title SITE PLAN 1" = 20'-0" checked









LINE OF SIGHT DIAGRAM

1/4" = 1'-0"

Adam Stillman Residential Design

Avenue Sinclair 35

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title LINE OF SIGHT DIAGRAM

scale 1/4" = 1'-0" checked

date 10-11-2021

sheet no. 351Sinclair