

Project Description - 370 Sinclair Avenue NE

This application for a Certificate of Appropriateness includes a rear addition to the existing twostory contributing structure and interior renovations to the existing house. The house was constructed in 1900, according to Fulton County tax records.

Proposed renovations to the existing house:

- 1. Interior renovations (not be visible from the exterior of the house.)
- 2. Remove and replace non-historic windows in existing rear addition.

Proposed addition to the house:

1. Construct a rear addition containing a dining room, screen porch, and exterior stairs. The wall height and eave overhangs of the addition will match those of the existing kitchen addition. The existing corner trim differentiates the original house from previous and proposed additions. Exterior materials will include, smooth-face hardiplank lap siding matching the reveal of the original wood siding, wood trim, and an asphalt roof. New windows will be wood simunlated divided light double hung with permanently affixed exterior muntins and 6" dividing mullions for ganged windows.

Site:

1. Remove existing deck and stairs, and portion of stone walkway.



Front elevation - no changes proposed



Rear elevation



Right side from rear



Left side elevation facing Washita



Non-historic windows in existing addition to be removed



Lower level screen porch to remain

H 0 Ven V

Sinclair

architect seal

ISSUED FOR CONSTRUCTION

All drawings are the property of Adam Stillma and must be returned at the completion of work. They shall not be reproduced, modified, or revised in any way without written consent. The contractor shall check and verify all dimensions and report any discrepancies before proceeding with the work. Adam Stillman shall protect this copyright and be reimbursed for all legal and court costs, etc., for any necessary protection of the drawings. Submission of these drawings to any public body for any use does not release in any way the copyright and ownership of drawings

provisions listed herein. COVER SHEET & SURVEY

checked

04-01-2022 project no.

sheet no. 370Sinclair

CONTRACTOR/OWNER/24 HR CONTACT

Tamara and John Huston 370 Sinclair Ave NE Atlanta GA 30307 404—395—0706

ADAM STILLMAN 350 SINCLAIR AVE NE ATLANTA, GA 30307 770–330–3389

STANDARD CONSTRUCTION CODES:

International Residential Code, 2018 Edition, with Georgia Amendments (2020) International Fire Code, 2018 Edition (no Georgia Amendments) International Plumbing Code, 2018 Edition, with Georgia Amendments (2020) International Mechanical Code, 2018 Edition, with Georgia Amendment (2020) International Fuel Gas Code, 2018 Edition, with Georgia Amendment (2020) National Electrical Code, 2020 Edition (no Georgia Amendments) International Energy Conservation Code, 2015 Edition, with Georgia Supplements and Amendments (2020) International Swimming Pool and Spa Code, 2018 Edition, with GA Amendments (2020)

PROJECT NAME: Huston Residence SCOPE OF WORK: Renovate existing house; construct rear addition with dining room, screen porch, and exterior stairs. Replace non-historic windows in existing kitchen addition TYPE OF CONSTRUCTION: V-B NUMBER OF STORIES: 2+basement

2018 NFPA 101 - Life Safety Code 2018 Edition with State Amendments (2020)

International Building Code, 2018 Edition, with Georgia Amendments (2020)

PROPOSED FLOOR AREAS:

BUILDING HEIGHT: 28'-4"

MAIN (EXISTING): MAIN (ADDITION): UPPER (EXISTING): 981 sf TOTAL: 2348 sf

NOTE: NO ATTIC SPACE EXCEEDS 7' HEADROOM; 674 sf BASEMENT NOT INCLUDED IN FLOOR AREA PER SECTION 16-24.008.(1)

UNHEATED AREAS:

PORCH/STEPS (EXISTING): 308 sf SCREEN PORCH: 128 sf

EXISTING ACCESSORY STRUCTURE AREAS:

GARAGE: 489 sf (20.8% OF MAIN HOUSE) 571 sf (24.5% OF MAIN HOUSE)

DRAWING INDEX: A-0 COVER SHEET SURVEY

S-1 SITE PLAN

A-1 MAIN LEVEL FLOOR PLANS

FLOOD HAZARD: NO

TERMITE: SEVERE

WEATHER: MODERATE

FRONT LINE DEPTH: 12"

MEAN ANNUAL TEMP: 66.2°

WINTER DESIGN TEMP: 22°

GROUND SNOW LOAD: 5 psf

SEISMIC DESIGN CATEGORY: B

TYP. DEAD LOADS: 10 psf


TYP. LIVE LOADS: 40 psf

TYP. ROOF LOADS: 20 psf LIVE/15 psf DEAD

WIND SPEED/CATEGORY: 115 mph/B

BASEMENT FLOOR PLANS

ELEVATIONS

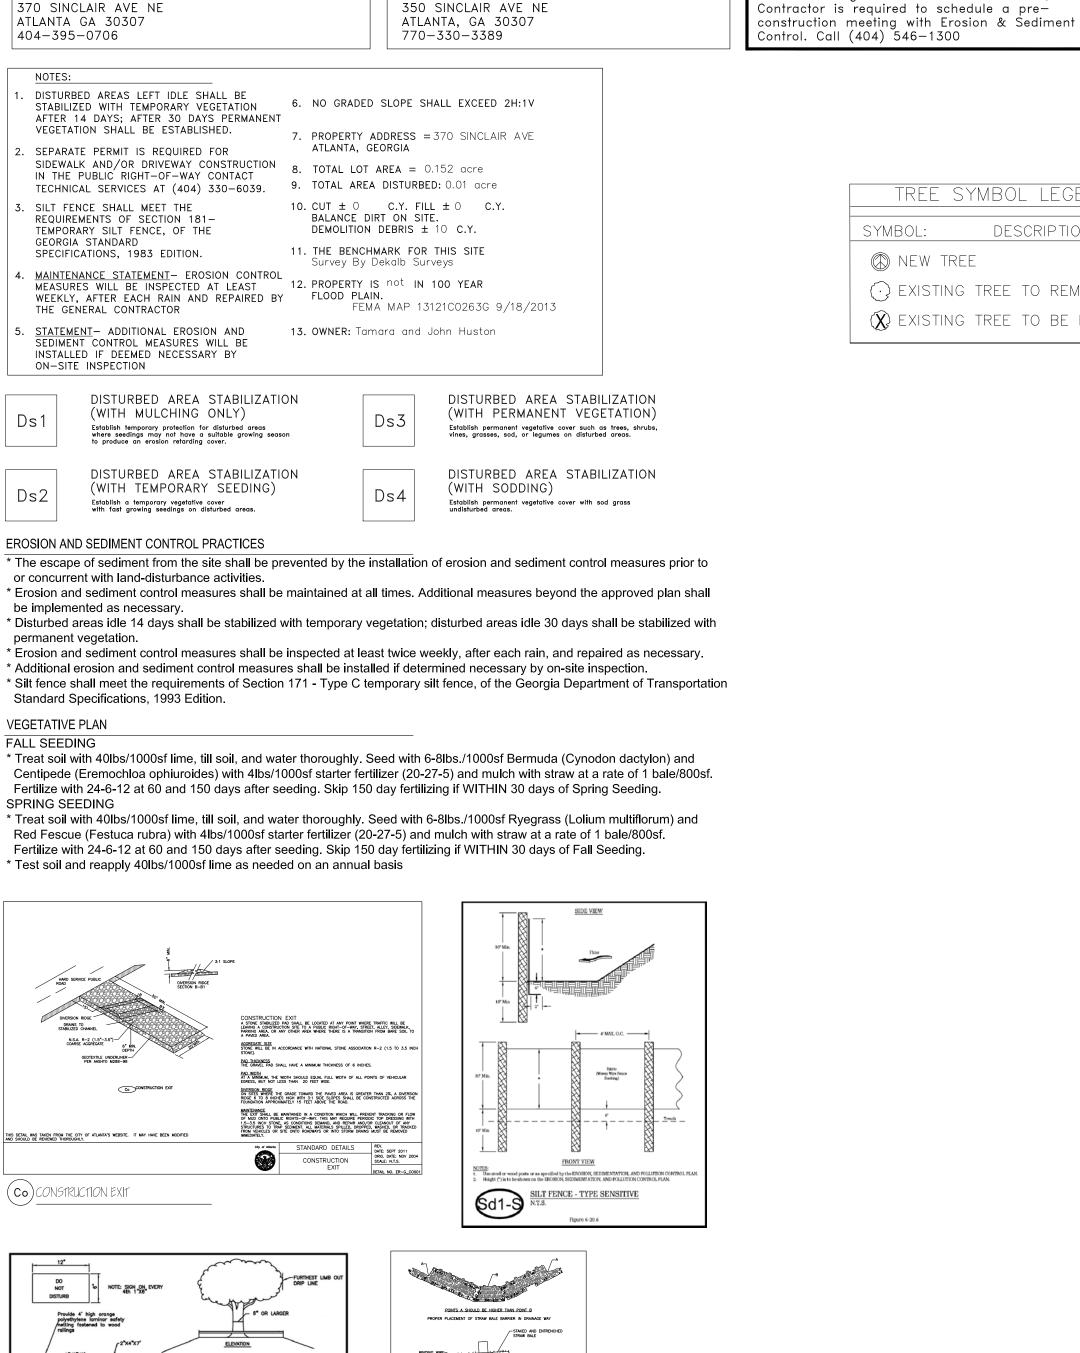



ARCHITECT

ADAM STILLMAN

OWNER/CONTRACTOR/24 HR CONTACT

Tamara and John Huston

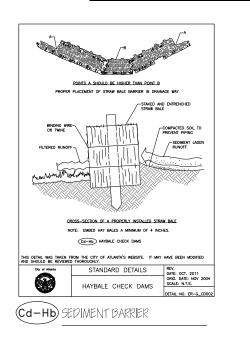

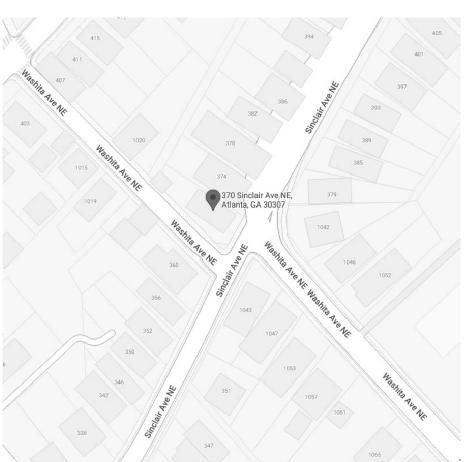

NOTES:

1. ALL TREE PROTECTION AREAS TO BE PROTECTED FROM SEDIMENTATION.

2. ALL TREE PROTECTION DEVICES TO BE INSTALLED PRIOR TO THE START OF THE LAND DISTURBANCE, AND MAINTAINED UNTIL FINAL LANDSCAPING

3. ALL TREE PROTECTION FENCING TO BE INSPECTED DAILY, AND REPAIRED OR REPLACED AS NEEDED.

4. NO PARKING, STORAGE OR OTHER CONSTRUCTION ACTIVITIES ARE TO OCCUR WITHIN TREE PROTECTION AREA.

5. ALL REQUIRED VEGETATION MUST BE MAINTAINED FOR TWO GROWING SEASONS AFTER THE DATE OF FINAL INSPECTION.

TREE PROTECTION FENCE

VICINITY MAP

NOT TO SCALE

TREE REPLACEMENT CALCULATION CHART Before starting land-disturbance activities, the Contractor is required to schedule a pre-

ontrol. Call (404) 546-1300

SYMBOL:

NEW TREE

TREE SYMBOL LEGEND

() EXISTING TREE TO REMAIN

(X) existing tree to be removed

DESCRIPTION:

TREES RECOMPENSE:

\$AMOUNT = \$100.00[(# OF TREES DESTROYED + # OF TREES LOST)]- # OF TREES REPLACED] + \$30.00 [(# DBH INCHES DESTROYED + # DBH INCHES LOST) - # CALIPER INCHES REPLACED]


+	\$100.00 x # OF TREES DESTROYED	+	\$100.00 ×	1 =	+\$	100.00
+	\$100.00 x # OF TREES LOST	+	\$100.00 x	0 =	+\$	0.00
_	\$100.00 x # OF TREES REPLACED	_	\$100.00 x	1 =	-\$	100.00
+	\$30.00 # DBH INCHES DESTROYED	+	\$30.00 x	9 =	+\$	270.00
+	\$30.00 # DBH INCHES LOST	+	\$30.00 x	0 =	+\$	0.00

- \$30.00 # CALIPER INCHES REPLACED - \$30.00 x 2.5 = -\$ 75.00

\$ AMOUNT = 195.00 NO WATERS OF THE STATE EXIST WITHIN 200' OF THE PROJECT SITE


NOTE: LIMITS OF DISTURBANCE COINCIDE WITH SILT FENCE



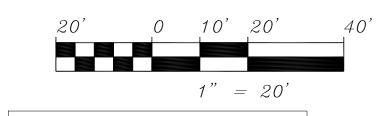

NO GRADED SLOPES SHALL EXCEED 2H:1V

--- EXISTING TO REMAIN --- EXISTING TO BE REMOVED --- NEW CONTOUR

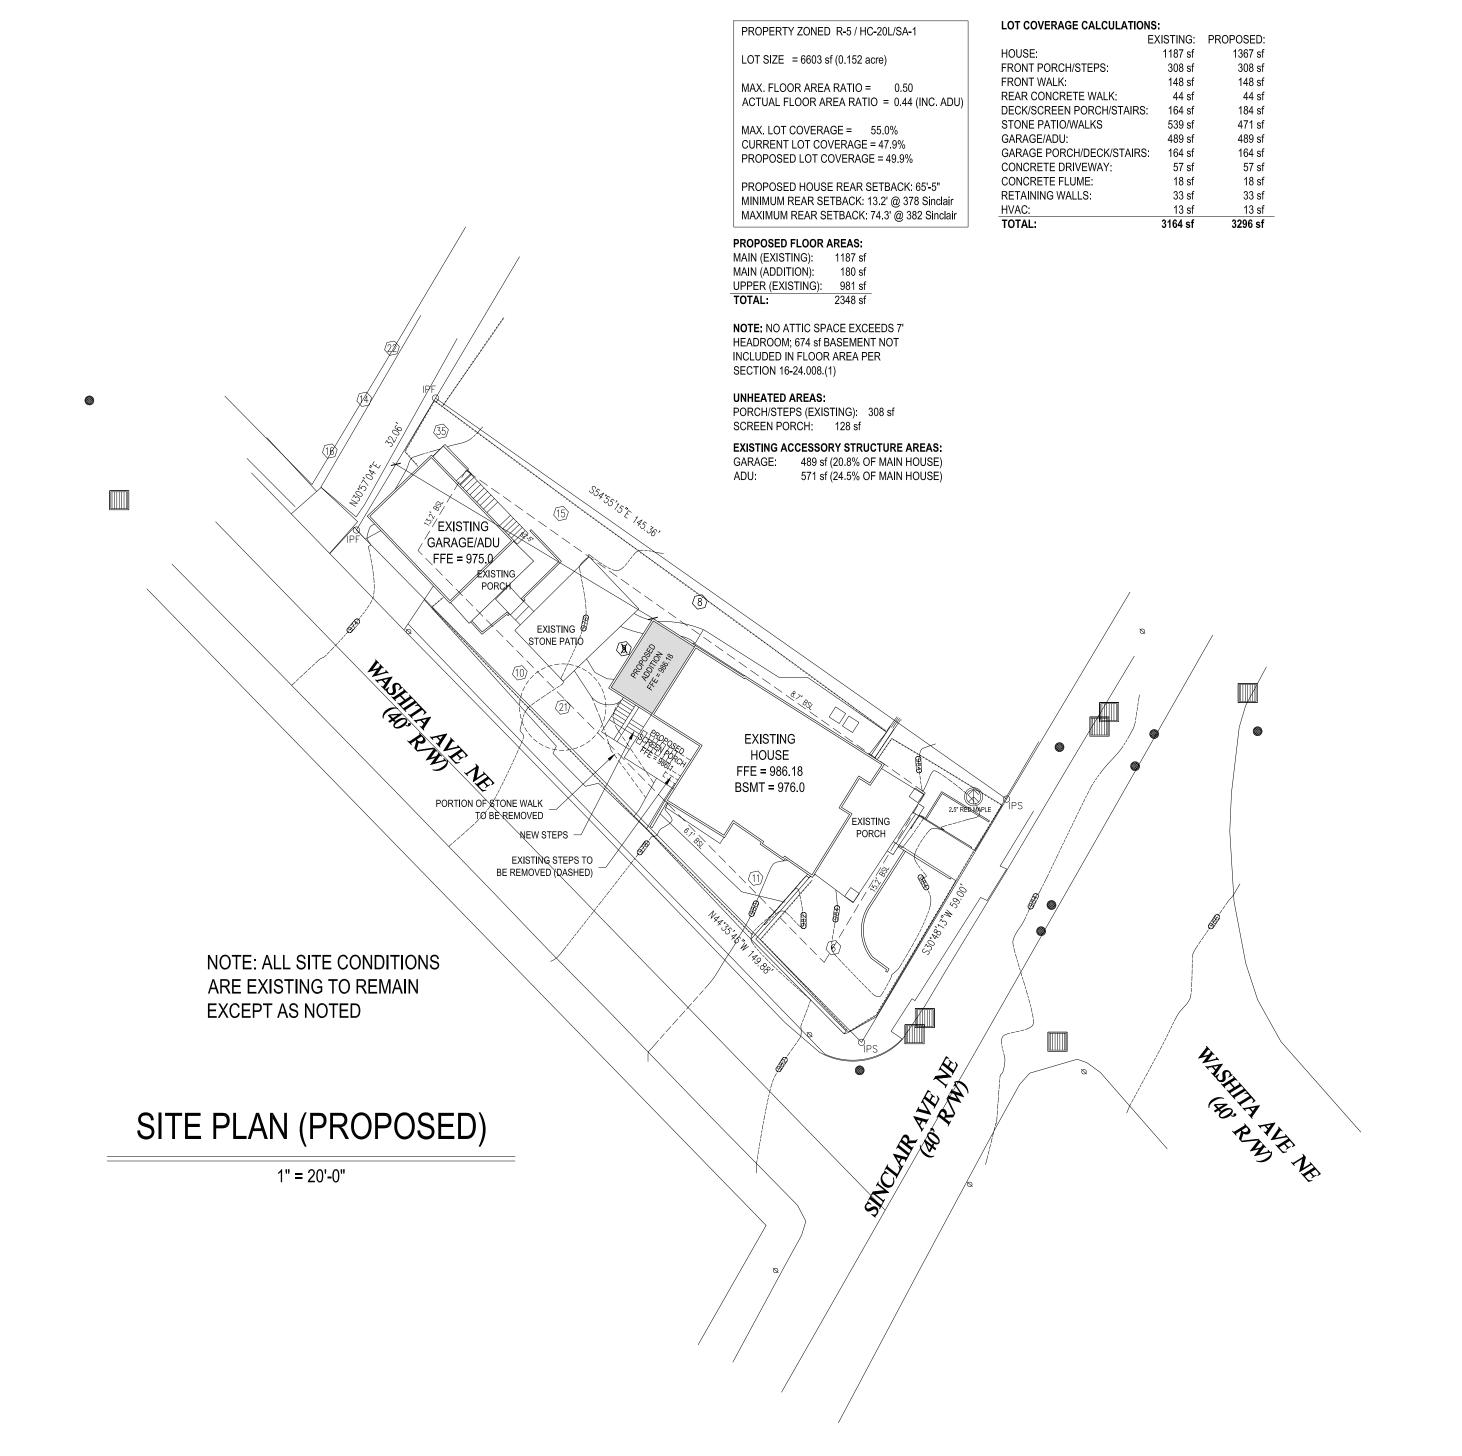

Stillman Itial Design Adam Resident en

(

J I 0 -B cl N -S 0

architect seal

ISSUED FOR CONSTRUCTION


All drawings are the property of Adam Stillma and must be returned at the completion of work. They shall not be reproduced, modified or revised in any way without written consent The contractor shall check and verify all dimensions and report any discrepancies before proceeding with the work. Adam


Stillman shall protect this copyright and be reimbursed for all legal and court costs, etc. for any necessary protection of the drawings. Submission of these drawings to any public body for any use does not release in any way the copyright and ownership of drawings provisions listed herein.

title SITE PLAN **scale** 1" = 20'-0" checked

04-01-20222

370Sinclai

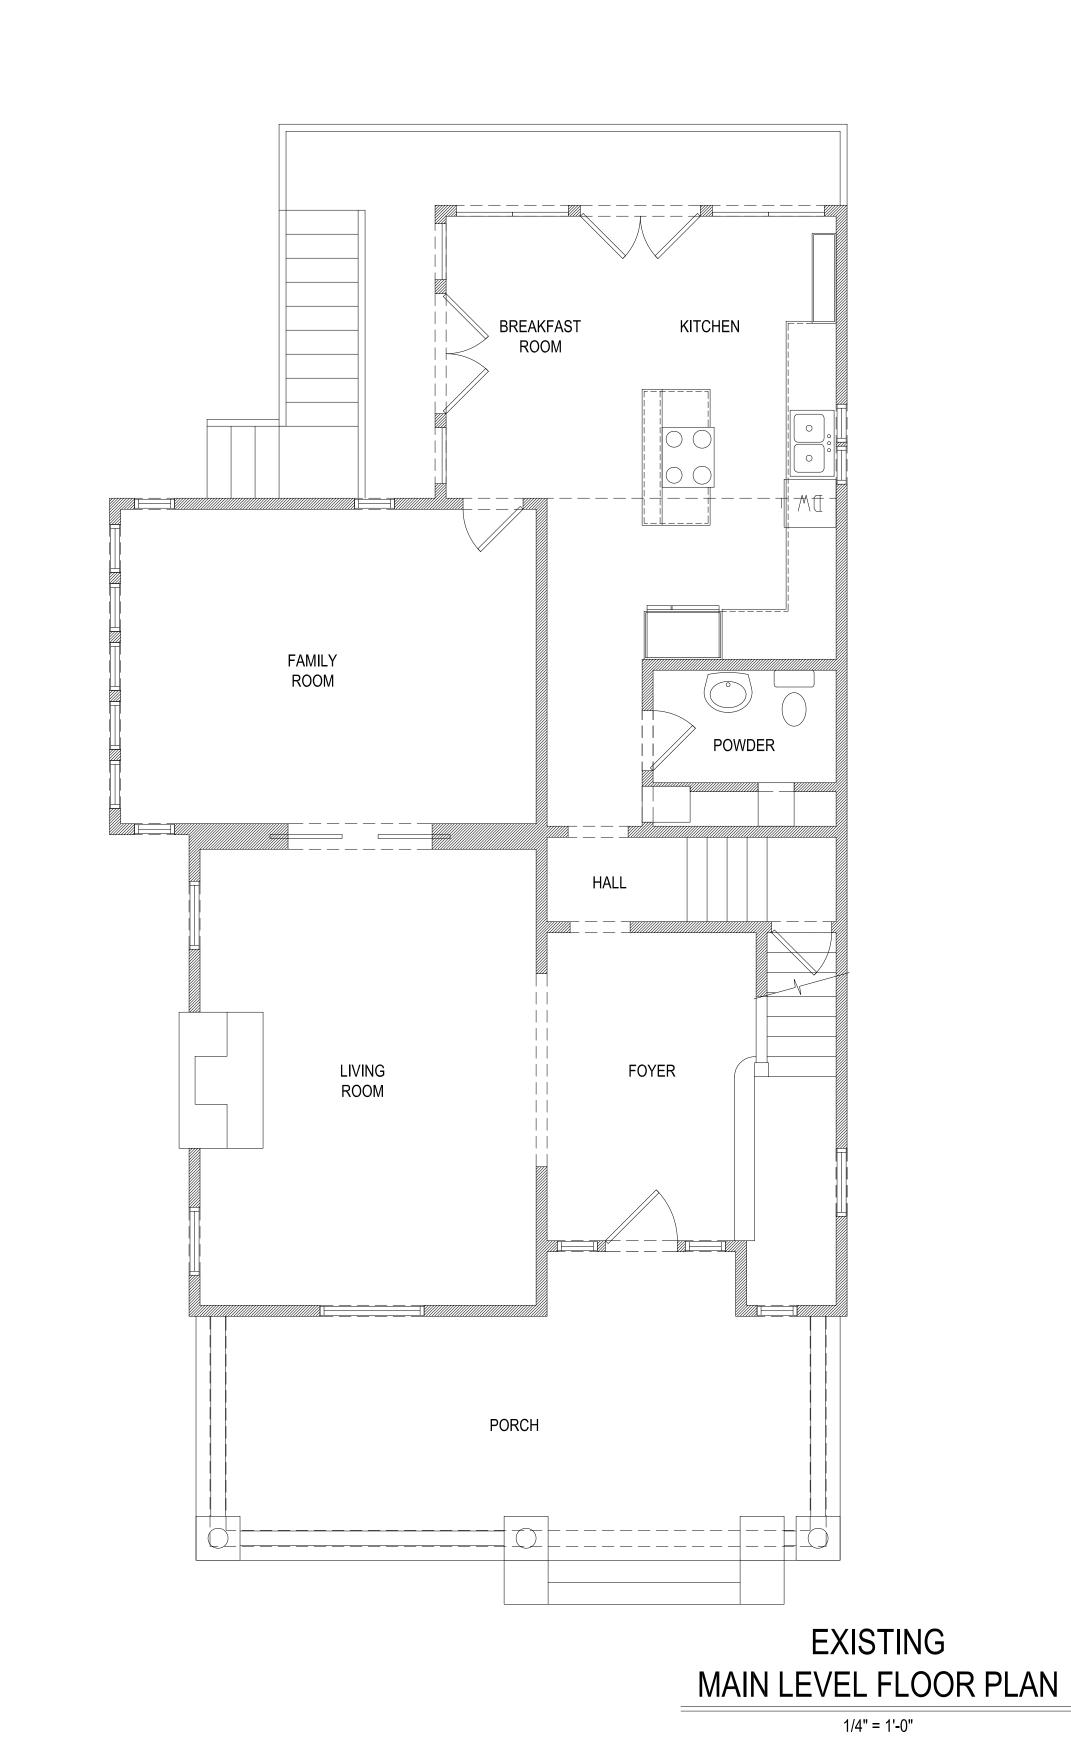

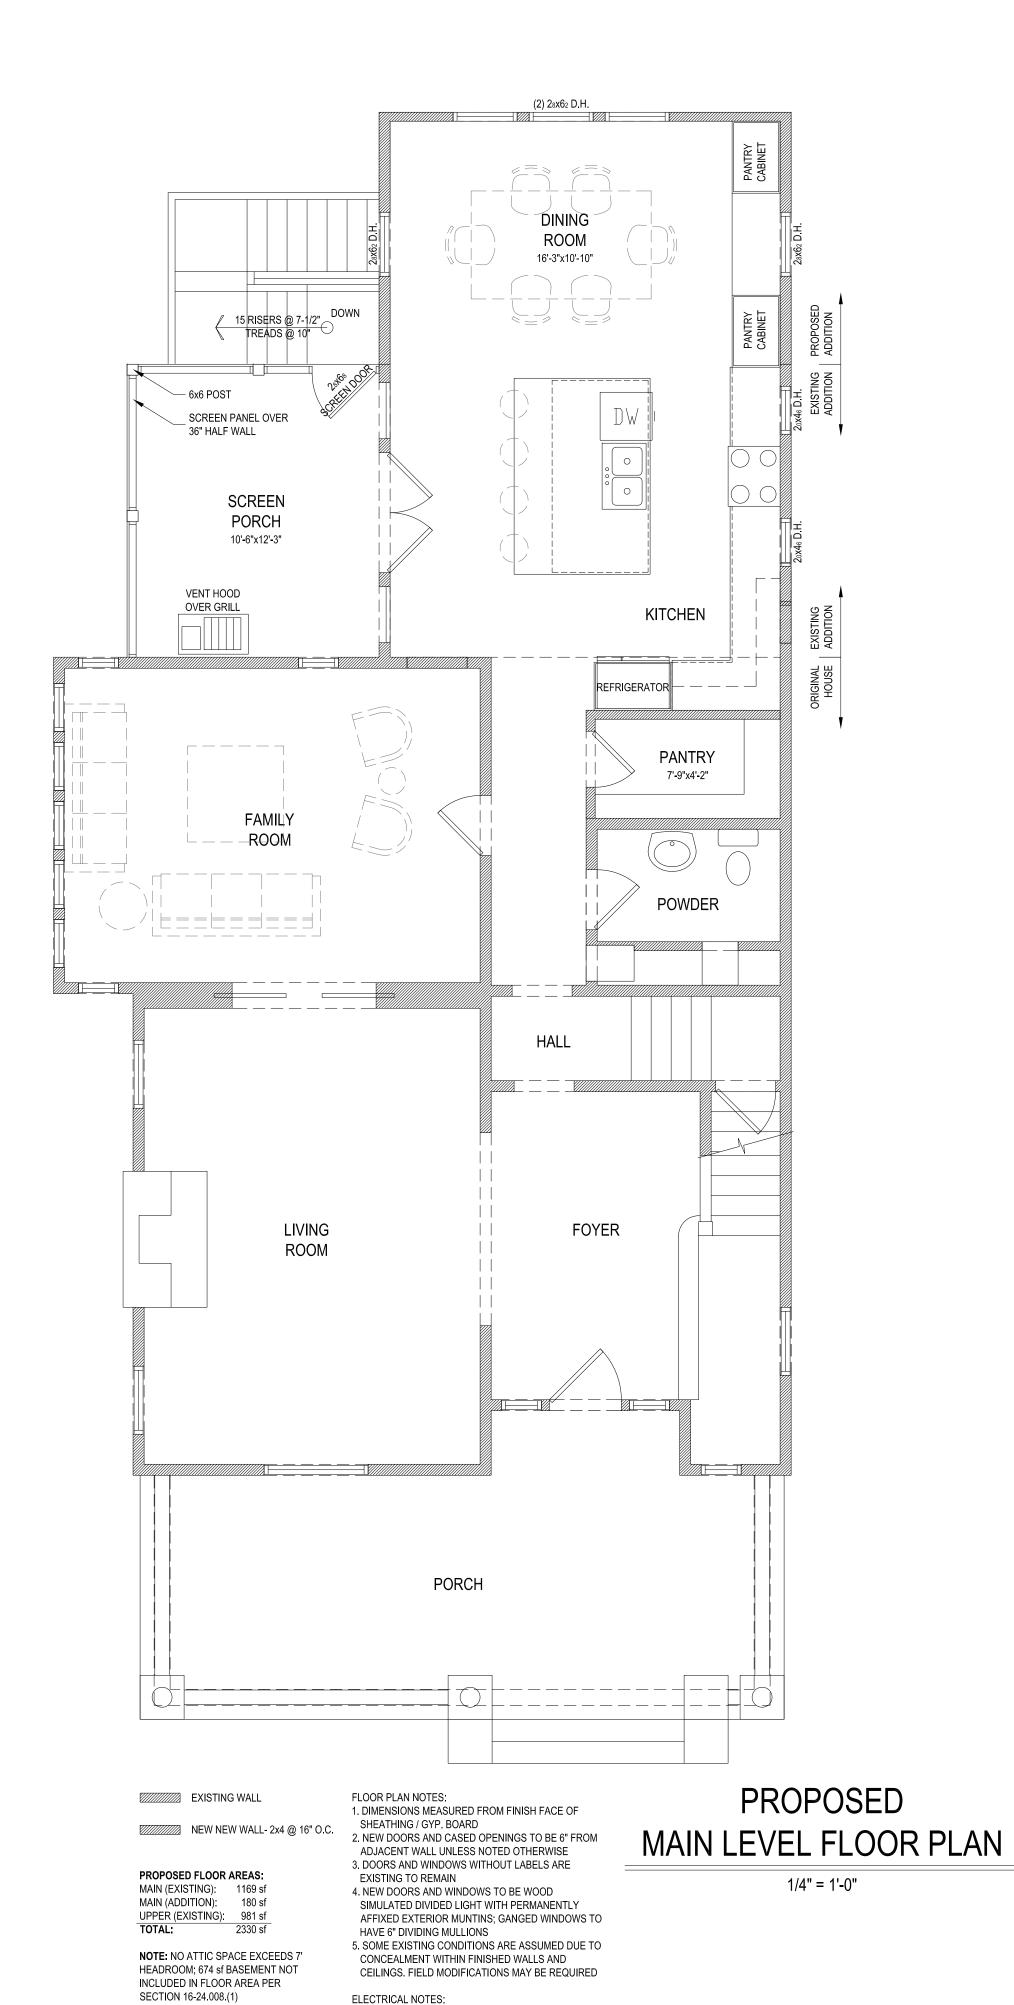

1. ELECTRICAL OUTLETS SHALL BE LOCATED PER IRC

E3901 WITH GFCI AND AFCI CIRCUIT PROTECTION

WHERE REQUIRED

UNHEATED AREAS:

PORCH (EXISTING): 294 sf

SCREEN PORCH: 128 sf

Adam Stillman Residential Design 0 venu A Sinclair 70 \mathcal{C} architect seal ISSUED FOR CONSTRUCTION All drawings are the property of Adam Stillma and must be returned at the completion of

work. They shall not be reproduced, modified,

or revised in any way without written consent.

The contractor shall check and verify all

dimensions and report any discrepancies

before proceeding with the work. Adam

Stillman shall protect this copyright and be

reimbursed for all legal and court costs, etc.,

for any necessary protection of the drawings.

Submission of these drawings to any public

body for any use does not release in any way

the copyright and ownership of drawings

titleMAIN LEVEL FLOOR PLANS

checked


sheet no.


provisions listed herein.

scale 1/4" = 1'-0"

04-01-2022

370Sinclair

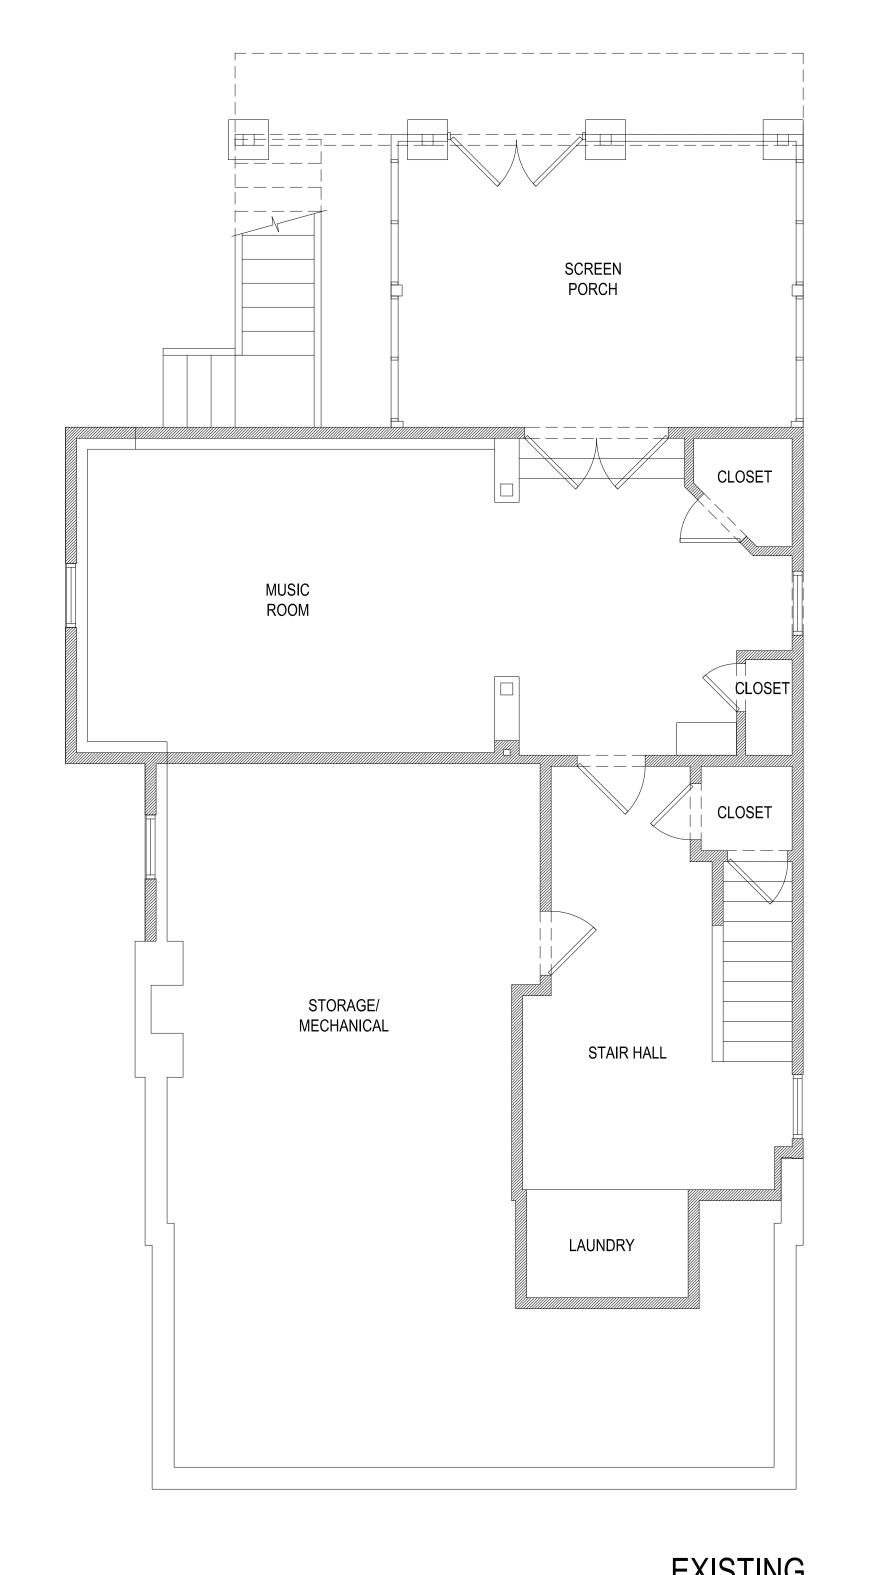

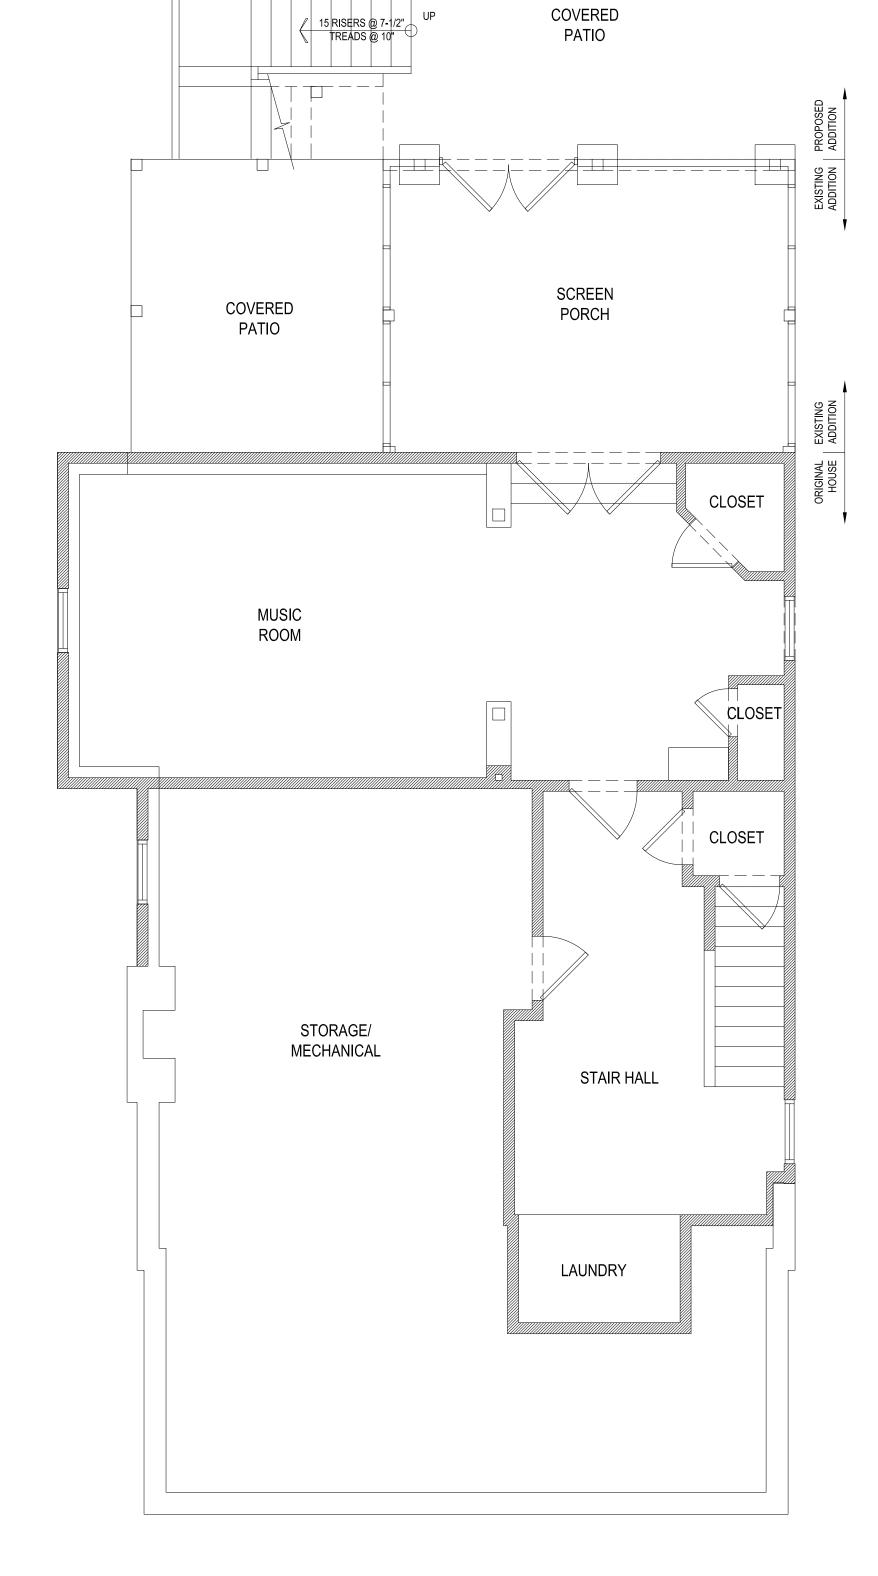

EXISTING BASEMENT LEVEL FLOOR PLAN 1/4" = 1'-0"

PROPOSED BASEMENT LEVEL FLOOR PLAN 1/4" = 1'-0"

Avenue Sinclair 70

architect seal

ISSUED FOR CONSTRUCTION All drawings are the property of Adam Stillman and must be returned at the completion of work. They shall not be reproduced, modified, or revised in any way without written consent. The contractor shall check and verify all dimensions and report any discrepancies before proceeding with the work. Adam Stillman shall protect this copyright and be reimbursed for all legal and court costs, etc., for any necessary protection of the drawings. Submission of these drawings to any public body for any use does not release in any way

title BASEMENT LEVEL FLOOR PLANS scale 1/4" = 1'-0" checked

the copyright and ownership of drawings provisions listed herein.

date 04-01-2022 project no.

sheet no.

A-1

